


NOTES CLIENT THIS DRAWING IS COPYRIGHT © OF TURNER. NO REPRODUCTION WITHOUT PERMISSION. UNLESS NOTED OTHERWISE THIS DRAWING IS NOT FOR CONSTRUCTION. ALL DIMENSIONS AND LEVELS ARE TO BE CHECKED ON SITE PRIOR TO THE COMMENCEMENT OF WORK. INFORM TURNER OF ANY DISCREPANCIES FOR CLARIFICATION BEFORE PROCEEDING WITH WORK. DRAWINGS ARE NOT TO BE SCALED. USE ONLY FIGURED DIMENSIONS. REFER TO CONSULTANT DOCUMENTATION FOR FURTHER INFORMATION.

Hutchinson Builders 23 Dunning Avenue, Rosebery NSW 2018





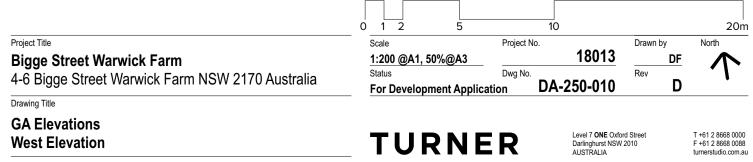

NOTES CLIENT THIS DRAWING IS COPYRIGHT © OF TURNER. NO REPRODUCTION WITHOUT PERMISSION. UNLESS NOTED OTHERWISE THIS DRAWING IS NOT FOR CONSTRUCTION. ALL DIMENSIONS AND LEVELS ARE TO BE CHECKED ON SITE PRIOR TO THE COMMENCEMENT OF WORK. INFORM TURNER OF ANY DISCREPANCIES FOR CLARIFICATION BEFORE PROCEDING WITH WORK. DRAWINGS ARE NOT TO BE SCALED. USE ONLY FIGURED DIMENSIONS. REFER TO CONSULTANT DOCUMENTATION FOR FURTHER INFORMATION. Hutchinson Builders 23 Dunning Avenue, Rosebery NSW 2018


DLCS Quality Endorsed Company ISO 9001:2008, Registration Number 20476 Nominated Architect: Nicholas Turner 6695, ABN 86 064 084 911


 Rev
 Date
 Approved by
 Issue Name

 A
 28.05.19
 VS
 Development Application

 B
 08.07.19
 VS
 Development Application

C 20.09.19 VS Development Application

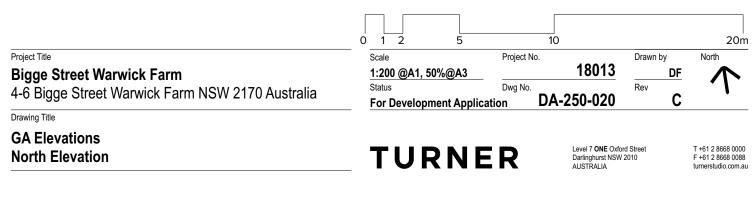

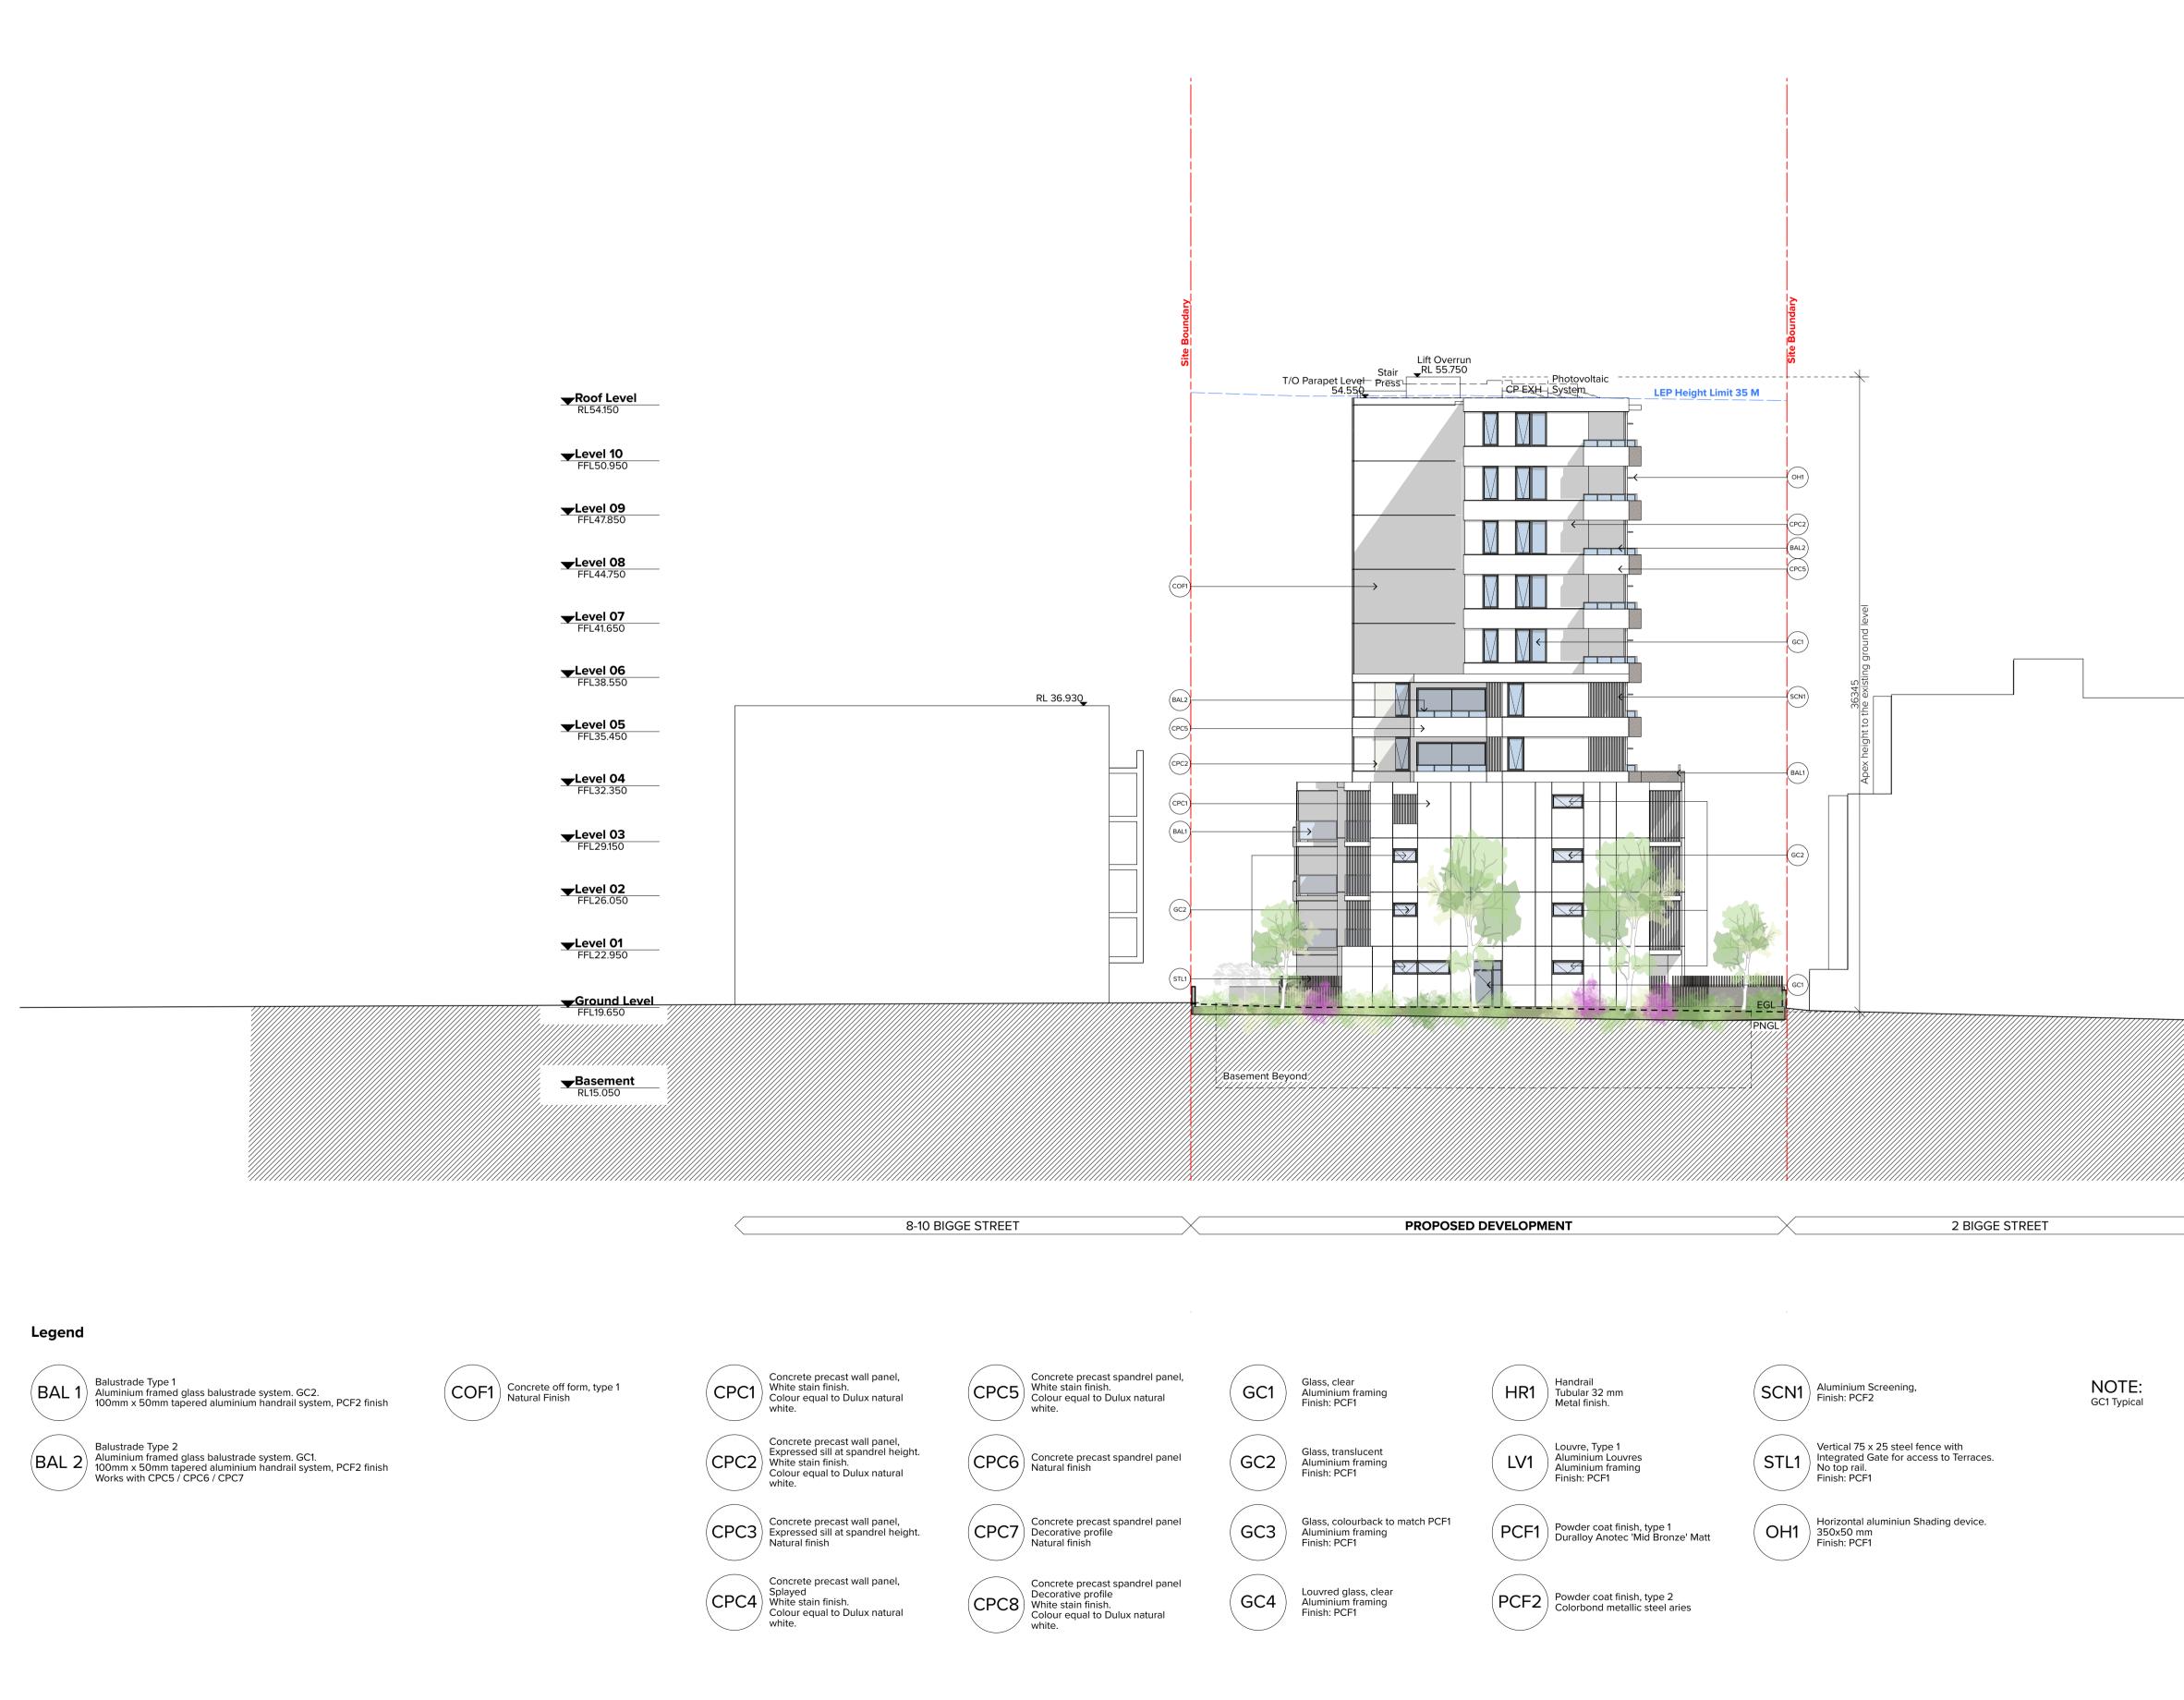

CLIENT THIS DRAWING IS COPYRIGHT © OF TURNER. NO REPRODUCTION WITHOUT PERMISSION. UNLESS NOTED OTHERWISE THIS DRAWING IS NOT FOR CONSTRUCTION. ALL DIMENSIONS AND LEVELS ARE TO BE CHECKED ON SITE PRIOR TO THE COMMENCEMENT OF WORK. INFORM TURNER OF ANY DISCREPANCIES FOR CLARIFICATION BEFORE PROCEDING WITH WORK. DRAWINGS ARE NOT TO BE SCALED. USE ONLY FIGURED DIMENSIONS. REFER TO CONSULTANT DOCUMENTATION FOR FURTHER INFORMATION. Hutchinson Builders 23 Dunning Avenue, Rosebery NSW 2018


NOTES


0 1 2 Project Title Scale Project No. Drawn by North _ DF Rev 18013 Bigge Street Warwick Farm 1:200 @A1, 50%@A3 \uparrow Status Dwg No.
For Development Application DA-250-030 4-6 Bigge Street Warwick Farm NSW 2170 Australia С Drawing Title **GA Elevations** Level 7 **ONE** Oxford Street Darlinghurst NSW 2010 AUSTRALIA T +61 2 8668 0000 F +61 2 8668 0088 turnerstudio.com.au TURNER East Elevation

20m



THIS DRAWING IS COPYRIGHT © OF TURNER. NO REPRODUCTION WITHOUT PERMISSION. UNLESS NOTED OTHERWISE THIS DRAWING IS NOT FOR CONSTRUCTION. ALL DIMENSIONS AND LEVELS ARE TO BE CHECKED ON SITE PRIOR TO THE COMMENCEMENT OF WORK. INFORM TURNER OF ANY DISCREPANCIES FOR CLARFICATION BEFORE PROCEDING WITH WORK. DRAWINGS ARE NOT TO BE SCALED. USE ONLY FIGURED DIMENSIONS. REFER TO CONSULTANT DOCUMENTATION FOR FURTHER INFORMATION. Hutchinson Builders 23 Dunning Avenue, Rosebery NSW 2018

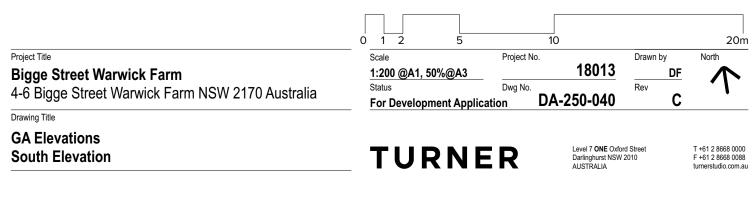

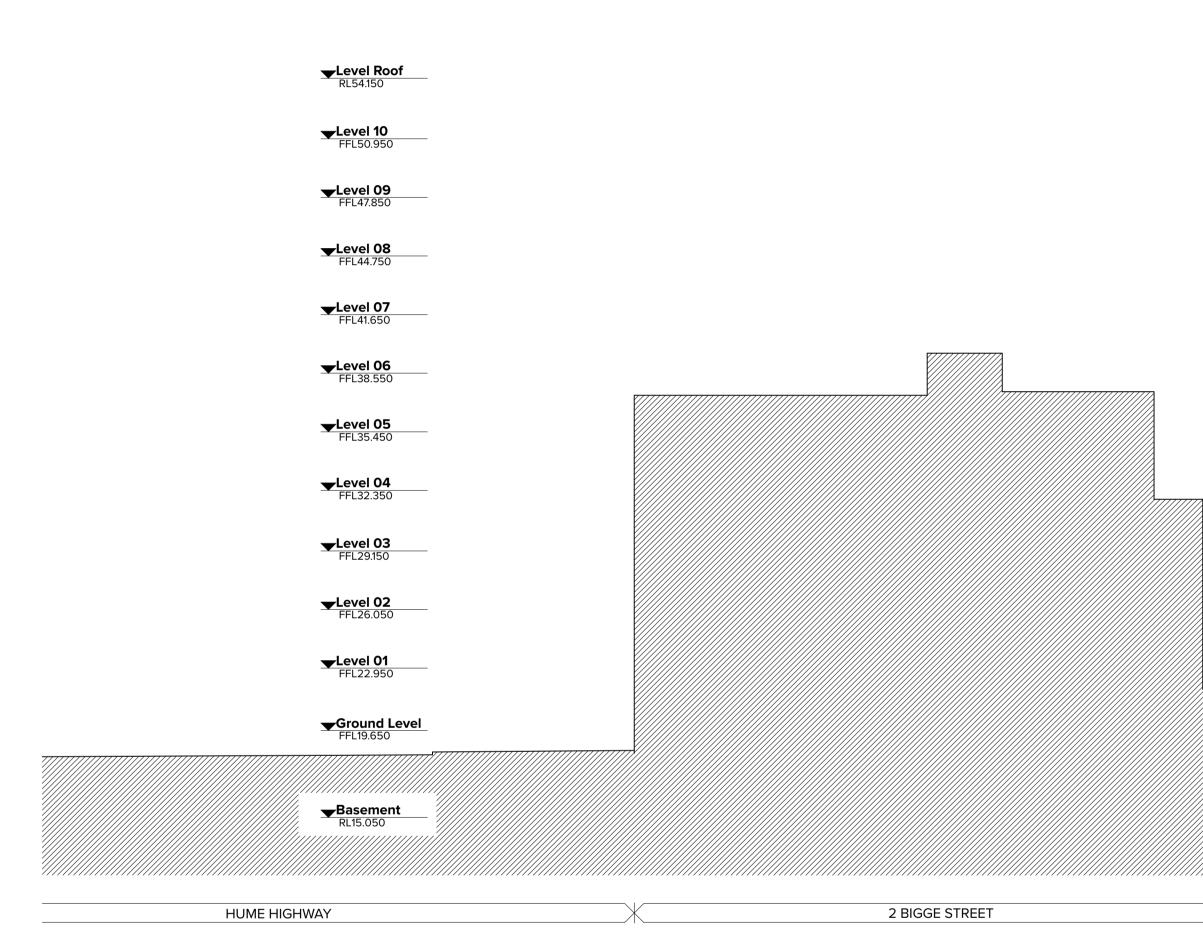


CLIENT

THIS DRAWING IS COPYRIGHT © OF TURNER. NO REPRODUCTION WITHOUT PERMISSION. UNLESS NOTED OTHERWISE THIS DRAWING IS NOT FOR CONSTRUCTION. ALL DIMENSIONS AND LEVELS ARE TO BE CHECKED ON SITE PRIOR TO THE COMMENCEMENT OF WORK. INFORM TURNER OF ANY DISCREPANCIES FOR CLARIFICATION BEFORE PROCEDING WITH WORK. DRAWINGS ARE NOT TO BE SCALED. USE ONLY FIGURED DIMENSIONS. REFER TO CONSULTANT DOCUMENTATION FOR FURTHER INFORMATION.

NOTES

Boundary				Boundary	
36.845 Apex height to the existing ground level	CL: Ceiling Level 10.02 9.02 8.02 7.02 6.02 5.02 4.02 3.02 2.02 10.2 0.02	Lift Overrun RL 55.750 Stair Press 9.01 9.01 8.01 7.01 6.01 6.01 5.01 4.01 4.01 Hot Water Plant 2.08 Waste Holding Waste	LEP Height Limit 35 M [RL 54]		aitments
	PROPOSED	DEVELOPMENT		8-10 BIGGE STREET	X

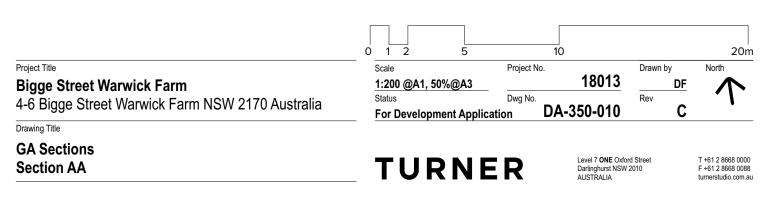




CLIENT

THIS DRAWING IS COPYRIGHT © OF TURNER. NO REPRODUCTION WITHOUT PERMISSION. UNLESS NOTED OTHERWISE THIS DRAWING IS NOT FOR CONSTRUCTION. ALL DIMENSIONS AND LEVELS ARE TO BE CHECKED ON SITE PRIOR TO THE COMMENCEMENT OF WORK. INFORM TURNER OF ANY DISCREPANCIES FOR CLARIFICATION BEFORE PROCEDING WITH WORK, DRAWINGS ARE NOT TO BE SCALED. USE ONLY FIGURED DIMENSIONS. REFER TO CONSULTANT DOCUMENTATION FOR FURTHER INFORMATION.

NOTES

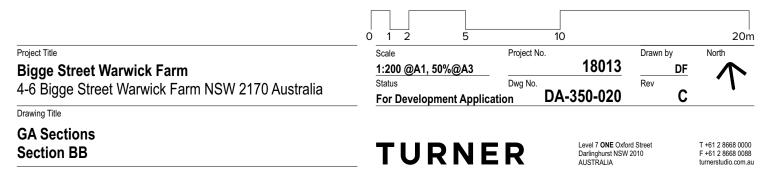




CLIENT Hutchinson Builders 23 Dunning Avenue, Rosebery NSW 2018

THIS DRAWING IS COPYRIGHT © OF TURNER. NO REPRODUCTION WITHOUT PERMISSION. UNLESS NOTED OTHERWISE THIS DRAWING IS NOT FOR CONSTRUCTION. ALL DIMENSIONS AND LEVELS ARE TO BE CHECKED ON SITE PRIOR TO THE COMMENCEMENT OF WORK. INFORM TURNER OF ANY DISCREPANCIES FOR CLARIFICATION BEFORE PROCEDING WITH WORK. DRAWINGS ARE NOT TO BE SCALED. USE ONLY FIGURED DIMENSIONS. REFER TO CONSULTANT DOCUMENTATION FOR FURTHER INFORMATION.

NOTES




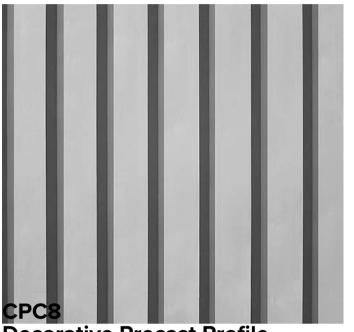

Decorative Precast Profile






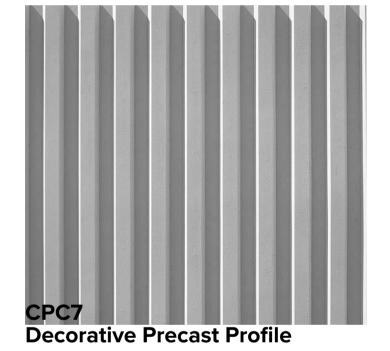

CPC1 / CPC2 / CPC4 / CPC5



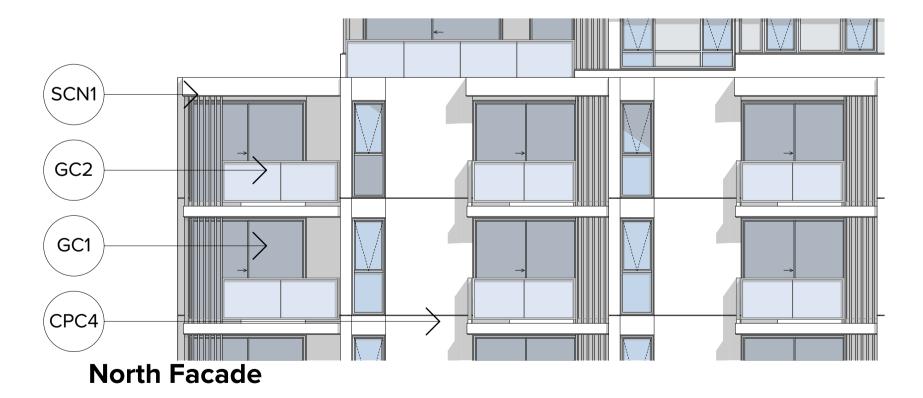












Legend

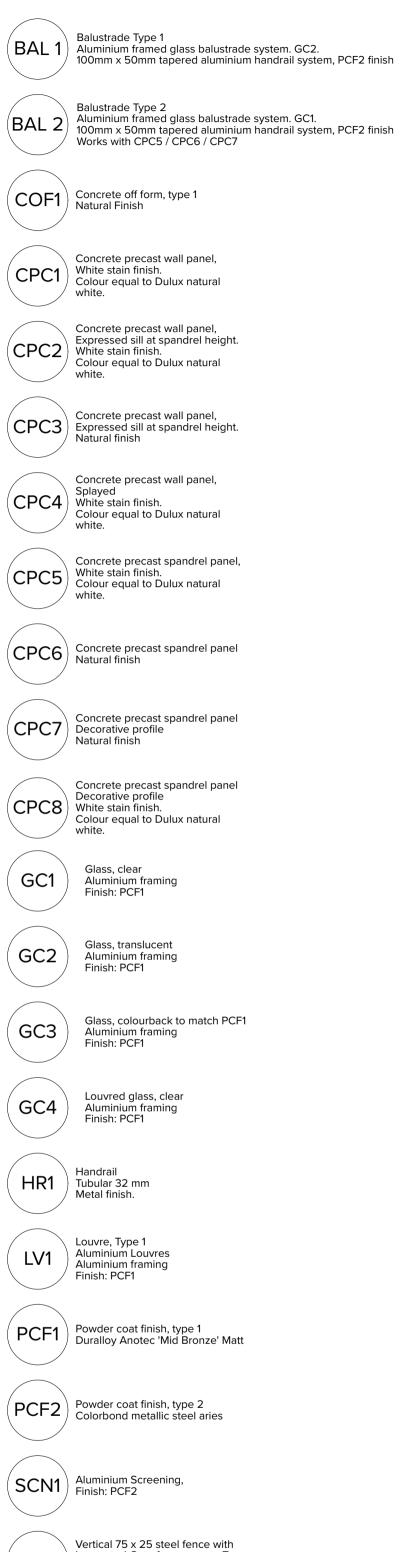

Balustrade Type 2 (BAL 2) Aluminium framed glass balustrade system. GC1. 100mm x 50mm tapered aluminium handrail system, PCF2 finish Works with CPC5 / CPC6 / CPC7 (COF1) Concrete off form, type 1 Natural Finish Concrete precast wall panel, White stain finish. Colour equal to Dulux natural white. Concrete precast wall panel, (CPC2) Expressed sill at spandrel height. White stain finish. Colour equal to Dulux natural white. (CPC3) Concrete precast wall panel, Expressed sill at spandrel height. Natural finish CPC4 CPC4 CPC4 Concrete precast wall panel, Splayed White stain finish. Colour equal to Dulux natural white. Concrete precast spandrel panel, (CPC5) White stain finish. Colour equal to Dulux natural white. (CPC6) Concrete precast spandrel panel Natural finish (CPC7) Concrete precast spandrel panel Decorative profile Natural finish Concrete precast spandrel panel Decorative profile (CPC8) Decorative profile White stain finish. Colour equal to Dulux natural white. Glass, clear Aluminium framing Finish: PCF1 Glass, translucent Aluminium framing Finish: PCF1 Glass, colourback to match PCF1 Aluminium framing Finish: PCF1 Louvred glass, clear Aluminium framing Finish: PCF1 Handrail Tubular 32 mm Metal finish. LV1 LV1 LV1 LV1 LU1 Louvre, Type 1 Aluminium Louvres Aluminium framing Finish: PCF1 (PCF1) Powder coat finish, type 1 Duralloy Anotec 'Mid Bronze' Matt (PCF2) Powder coat finish, type 2 Colorbond metallic steel aries

(SCN1) Aluminium Screening, Finish: PCF2

Vertical 75 x 25 steel fence with (STL1) Integrated Gate for access to Terraces. No top rail. Finish: PCF1

OH1 Horizontal aluminiun Shading device. 350x50 mm Finish: PCF1

4-6 Bigge Street Warwick Farm NSW 2170 Australia

Scale Project No. Drawn by 18013 DF Rev <u>1:100 @A1, 50%@A3</u>
 Status
 Dwg No.

 For Development Application
 DA-830-010
 С

North

TURNER


Level 7 **ONE** Oxford Street Darlinghurst NSW 2010 AUSTRALIA

T +61 2 8668 0000 F +61 2 8668 0088 turnerstudio.com.au

SYDNEY DESIGN COLLECTIVE

Collaborative Landscape Architecture

4-6 Bigge Street, Liverpool | 01 Landscape Design Development

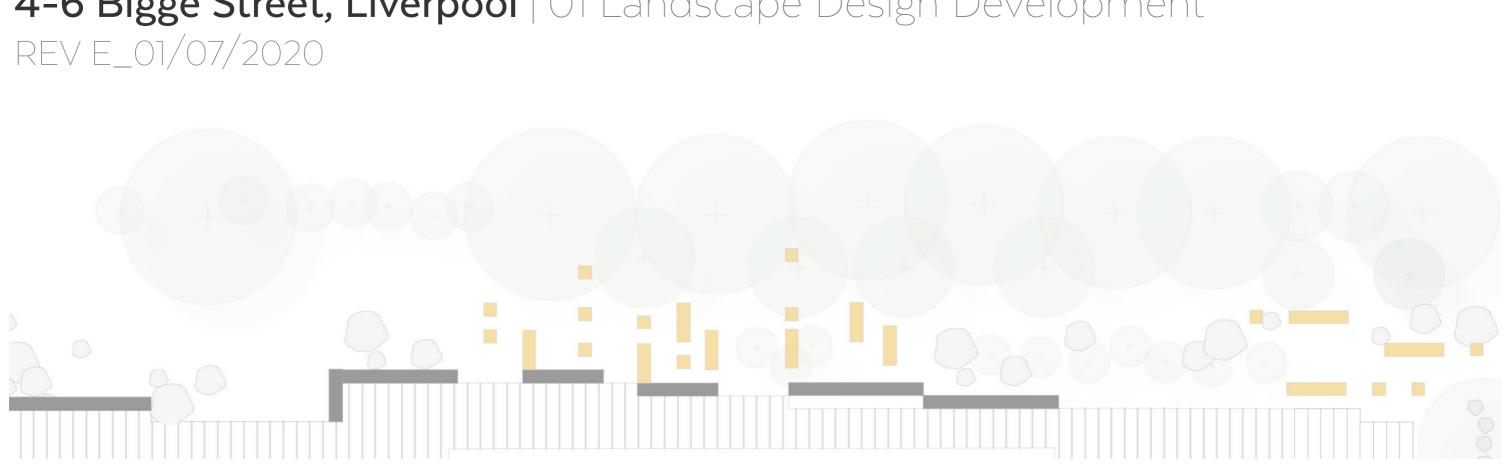

SYDNEY DESIGN COLLECTIVE

Client: Architect: Turner

Hutchinson Builders

Landscape Concept | Proposed Landscape Programme

Street Address and Green Relief

- Updatedplanting and surrogate large street trees to Liverpool City Council Public Domain Plan..
- Stone seats and as a landscape feature.
- Street Trees .
- Massed Planting


Northern Garden Rooms

- Differing character, landscape spaces, turf, and tree groves.
- Walls for seating and additional soil for trees.
- · Seperation between spaces for useability.







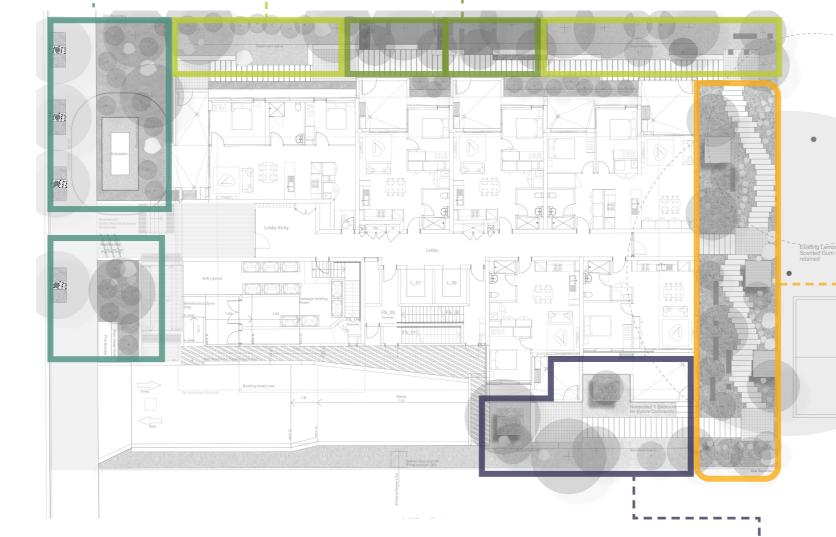

Communal Space (Southern)

- Open flexible space that is an extension of the communal .
- Trees in large planters for soil over basement.
- Concrete unit paving.




4-6 Bigge Street | Liverpool

Client: Hutchinson Builders SYDNEY DESIGN COLLECTIVE

Date: 01/07/2020

Application

Architect: Turner

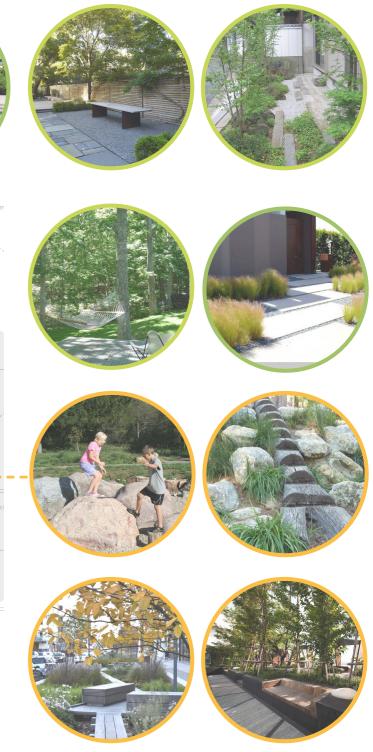


Shady Respite (Eastern Courtyard)

- Heavy shade from existing Eucalypt carefully protected and retained.
- Informal play integrated with seating and access .
- · Decks with composite timber finish for useability.

Landscape Development

Dwg no: LA-01 Rev: E

Landscape Base | Plan- Ground Floor

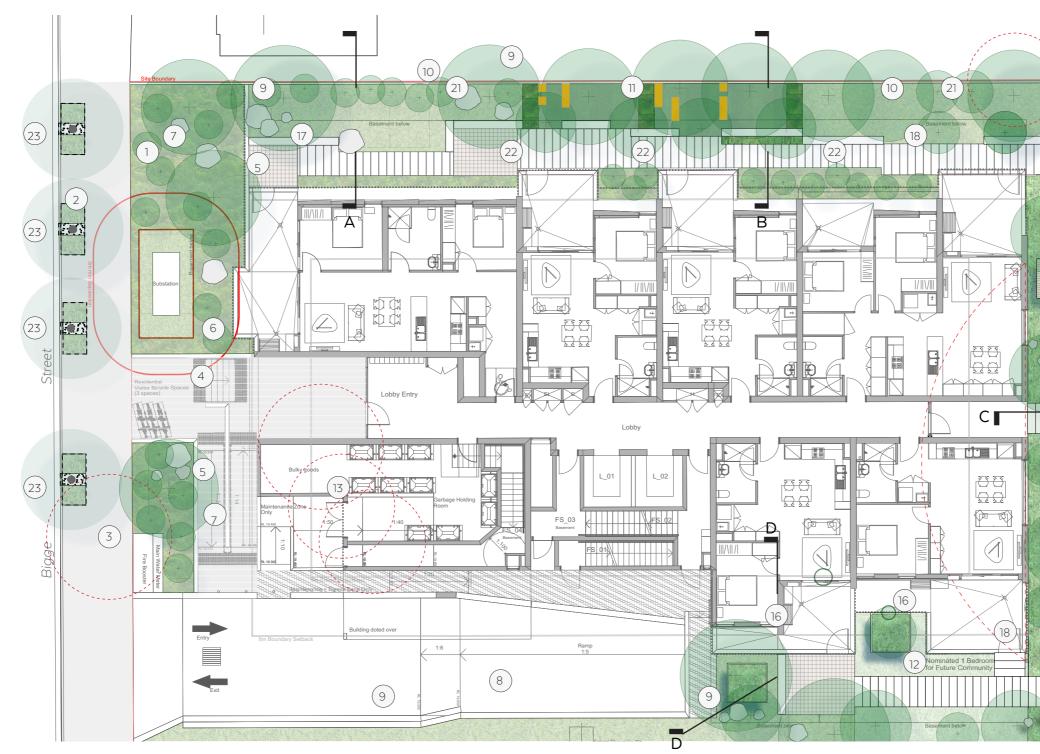

Legend

Street

Bigge

- 1. Streetscape to Liverpool City Centre Public Domain Plan (new insitu concrete footpath with full width paving and street trees).
- New street trees Lophostemon conferta (Brushbox) to Liverpool City Public Domain Plan. 2
- Existing Bottlebrush street tree removed for drive way line of sight. 3.
- 4. Special paving at front entry, with possibility for interpretation of Hoddle Grid Design to be developed further after DA.
- Large trees to supplement street within landscape setback. Proposed species to be 5. native rainforest tree, Silver Ash (Flindersia schottiana).
- Rounded boulders as a entry landscape feature and informal seating. All access ramp to 6. entrance.
- Native low and medium height shrub planting within landscape setback. 7.
 - 4-6 Bigge Street | Liverpool

- 8. Side setback low shrubs only to allow according to BCA fire access code requirements. 9. Boundary and privacy fence 1.8m tall.
- 10. Northern courtyard with varied landscape rooms to allow different groups of people to enjoy the spaces and to maximise amenity and provide different garden character.
- 11. Quiet communal garden with seating within beautiful planting for contemplation and relaxation.
- 12. Southern courtyard with flexibility communal use.
- 13. Small group of Bottlebrush and Pittosporum removed due to building work.
- 14. Lemon scented Gum removed for neighbouring development.
- 15. Existing large Lemon scented Gum in neighbouring property retained. Note there is some incursion into the root zone and the canopy will need to be shaped. Additional input from the project arborist required to direct protection method and strategy..

Client: Hutchinson Builders

Date: 01/07/2020 Scale: 1 : 200

Landscape Development Application

Architect: Turner

egress.

additional soil depth.

southern courtyard.

23. Kerb inlet (dolphin kerb) for passive irrigation of street trees, per Liverpool City Centre Public Domain Master Plan detail.



16. Planting in raised garden area with small trees in open bottom planter retaining edges for

17. Stone paving square for all access circulation and turning and to define seating nodes. 18. Informal plank paving, with butted joints and continuous path of travel or all access

19. Small trees in retaining edges in deep soil zone to give a cohesive character to the

20. Playscape of hopping logs, beams and decks for all ages.

21. Potential outdoor drying area as part of lawn gardens.


22. Shrub planting is raised garden over basement.

Dwg no: LA-02 Rev: E

Landscape Base – Site Section

Legend

- 1. 1.8m timber lapped and capped boundary fence.
- 2. Raised seating walls to create additional depth of soil over basement for growing small shade trees. Seating faces inwards from garden facing the access path.
- 3. Northern courtyard adjacent to indoor communal space with the shady garden and informal and smaller seating areas,
- 4. Large perimeter tree for privacy and screening with the deep soil zone.
- 5. Large planter over basement to continue garden on other side of path.
- 6. 1200mm all weather access path to all courtyard areas.
- 7. Additional small seating spaces throughout the communal garden.
- 8. Turf area with no mounding required over basement and perimeter facing wall facing in towards communal space.
- 9. Planted edge between wall and pathway.

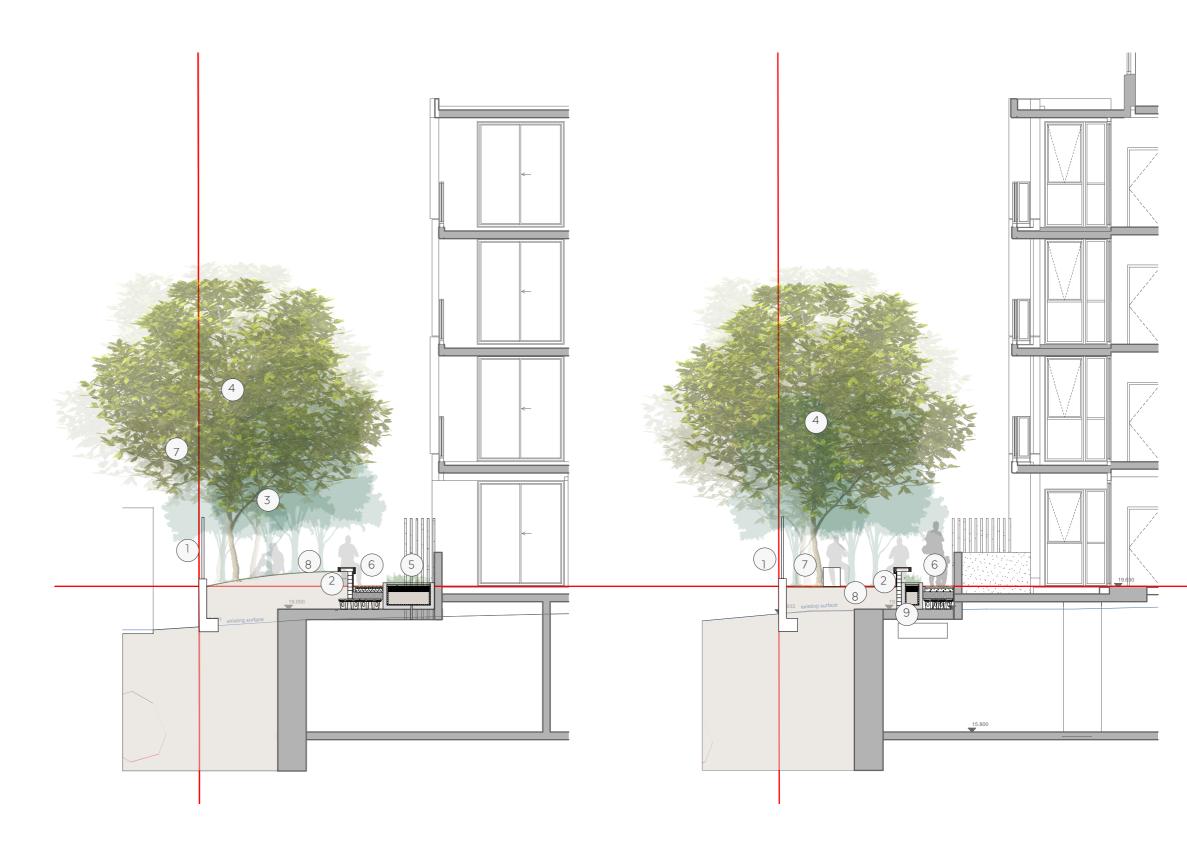

Landscape Section A- A - Scale 1:100

Client: Hutchinson Builders

SYDNEY DESIGN COLLECTIVE

Date: 01/07/2020

Application

Architect: Turner

Scale: 1 : 100


Landscape Section B- B - Scale 1:100

Landscape Base – Site Section

Legend

- 1. 1.8m timber lapped and capped boundary fence.
- 2. Raised seating walls to create additional depth of soil over basement for growing small shade trees. Seating faces inwards from garden facing the access path.
- 3. Northern courtyard adjacent to indoor communal space with the shady garden and informal and smaller seating areas,
- 4. Existing lemon scented gum tree to be retained.
- 5. Large planter over basement to continue garden on other side of path.
- 6. 1200mm all weather access path to all courtyard areas.
- 7. Additional small seating spaces throughout the communal garden.
- 8. Turf area with no mounding required over basement and perimeter facing wall facing in towards communal space.
- 9. Planted edge between wall and pathway.

10. Timer desk.

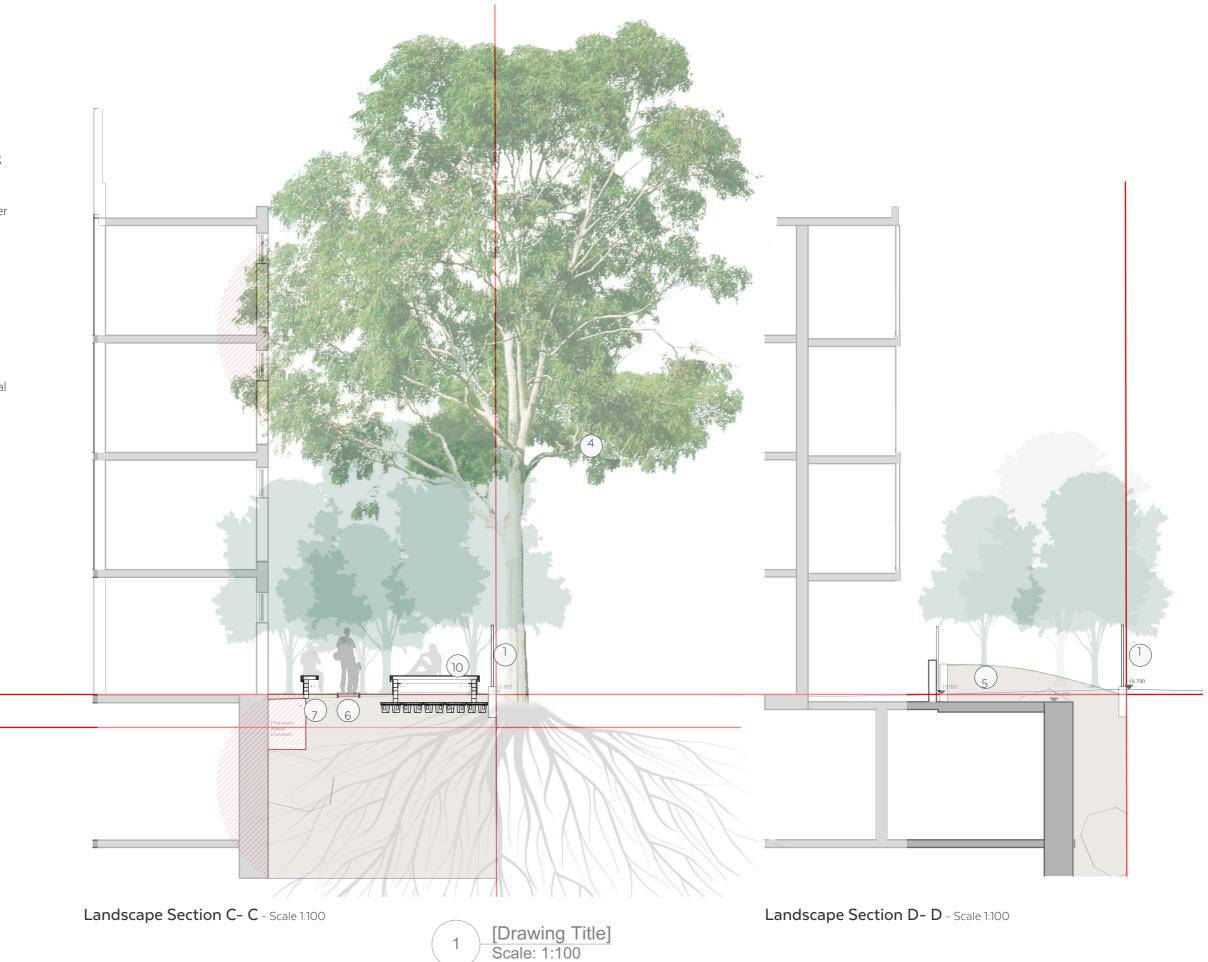

Client: Hutchinson Builders


Date: 01/07/2020 Scale: 1:100

SYDNEY DESIGN COLLECTIVE

Landscape Development

Dwg no: LA-04 Rev: E

Planting | Deep Soil Zones

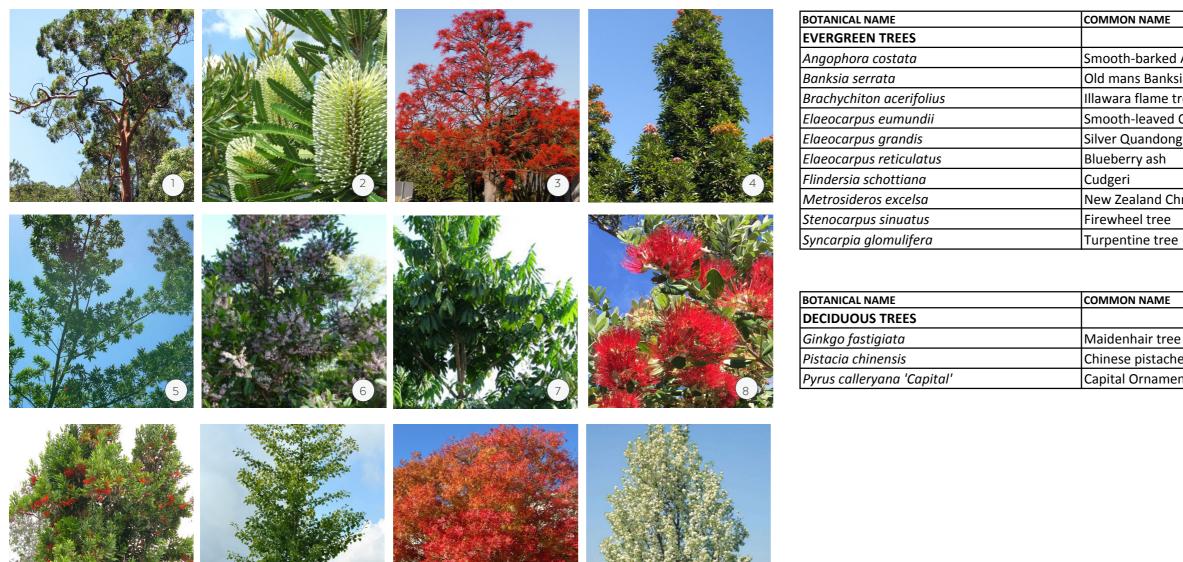

EVERGREEN TREES

- Angophora costata ٦.
- 2. Banksia serrata
- Brachychiton acerifolius 3.
- Elaeocarpus eumundii 4.
- 5. Elaeocarpus grandis
- 6. Elaeocarpus reticulatus
- Flindersia schottiana 7.
- Metrosideros excelsa 8.
- 9. Stenocarpus sinuatus

DECIDUOUS TREES

10. Ginkgo fastigiata 11. Pistacia chinensis

12. Pyrus calleryana 'Capital'

SYDNEY DESIGN COLLECTIVE


Client: Hutchinson Builders

Application

Architect: Turner

URE SIZE	POT SIZE
(12	400L
٢5	200L
κ 6	400L
(3	200L
(5	200L
3	200L
5	200L
(10	100L
(4	200L
(10	400L
	<pre>< 12 < 5 < 6 < 3 < 5 3 5 < 10 < 4 < 10</pre>

	MATURE SIZE	POT SIZE
e	8 x 2	400L
e	8 x 6	400L
ntal Pear	5 x 3	400L

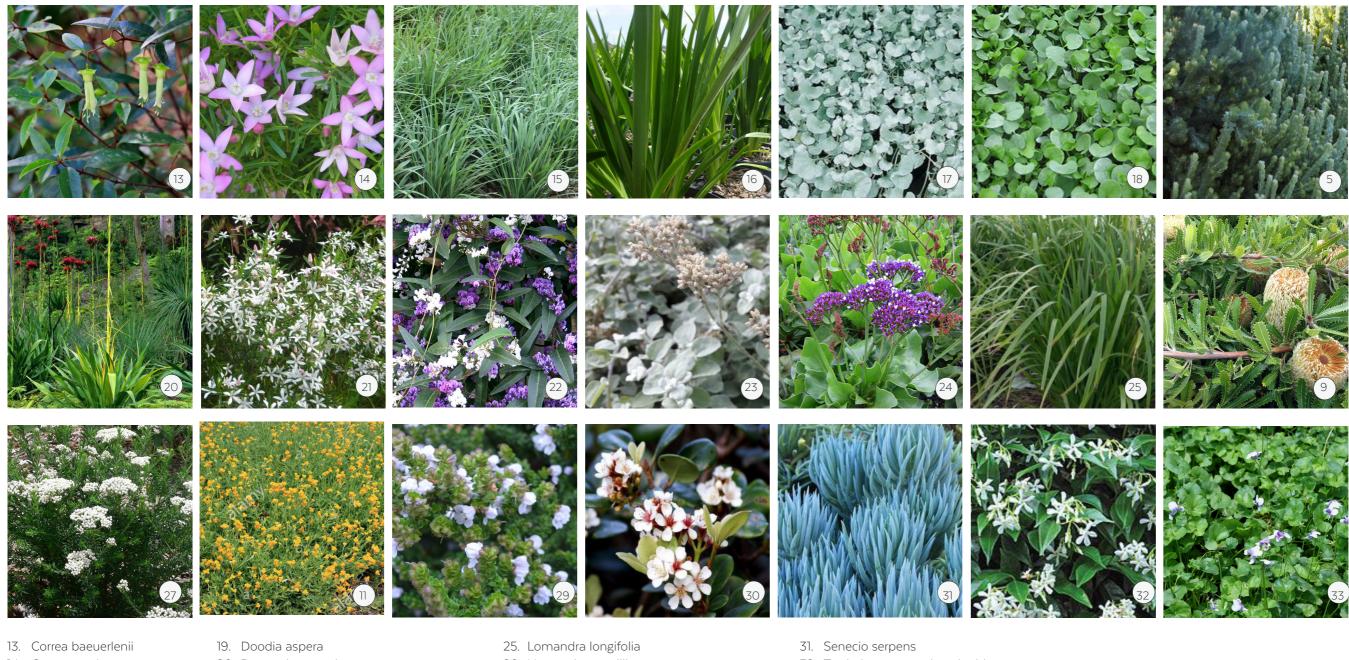

- 14. Crowea exaltata
- 15. Dianella caerulea
- 16. Dianella longifolia
- 17. Dichondra 'Silver Falls'
- 18. Dichondra 'repens
- 20. Doryanthes excelsa
- 21. Eriostemon myoporoides 'Profusion'
- 22. Hardenbergia spp.
- 23. Helichrysum petiolare
- 24. Limonium perezii

- 26. Neomarica gracillis
- 27. Ozothamnus diosmifolius 'Radiance'
- 28. Philodendron 'Xanadu'
- 29. Prostanthera cuneata
- 30. Rhaphiolepis 'Snow maiden'


- 32. Trachelospermum jasminoides
- 33. Viola hederacea

SYDNEY DESIGN COLLECTIVE

Client: Hutchinson Builders

Landscape Development Application

Dwg no: LA-06 Rev: E

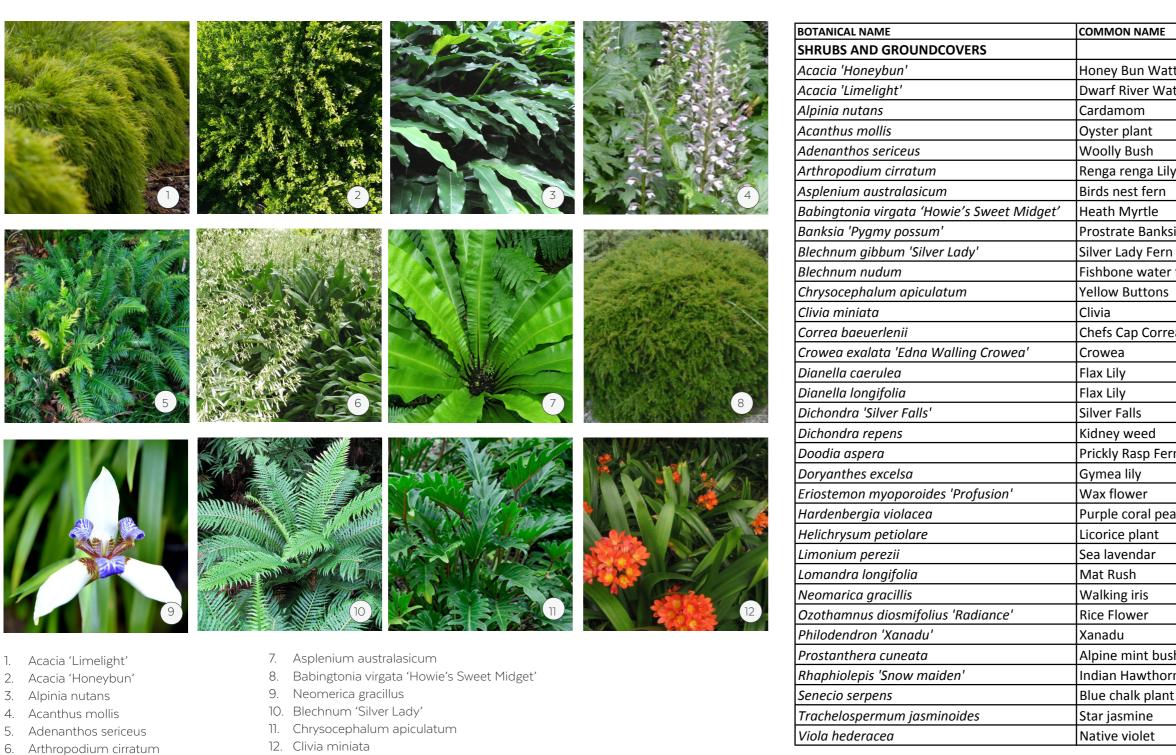


6.



Client: Hutchinson Builders

Architect: Turner

	MATURE SIZE	POT SIZE
tle	1.5 x1.5	300mm
ttle	1 x 1.2	200mm
	1 x 1.2	200mm
	0.7 x 0.7	200mm
	2 x 1	300mm
y	0.7 x 0.5	200mm
	1 x 1	200mm
	1 x 1	200mm
sia	0.5 x 2.5	200mm
	0.7 x 0.7	200mm
fern	0.7 x 0.7	200mm
	0.6 x 0.9	200mm
	0.7 x 0.7	200mm
ea	1.5 x 1.5	200mm
	0.45 x 0.8	200mm
	0.75 x 0.75	200mm
	0.8 x 0.5	200mm
	0.2 x 1.5	200mm
	0.3 x 1	200mm
'n	0.5 x 0.5	200mm
	1.5 x 1.5	
	0.8 x 0.8	200mm
a	0.4 x 3	200mm
	0.6 x 1.5	200mm
	0.6 x 0.6	200mm
	1 x 1	200mm
	0.6 x 0.9	200mm
	1.5 x 1	300mm
	0.75 x 0.75	200mm
h	0.5 x 0.5	200mm
'n	0.75 x 0.5	300mm
t	0.3 x 1	200mm
	5 x 1	200mm
	0.2 x 2	200mm

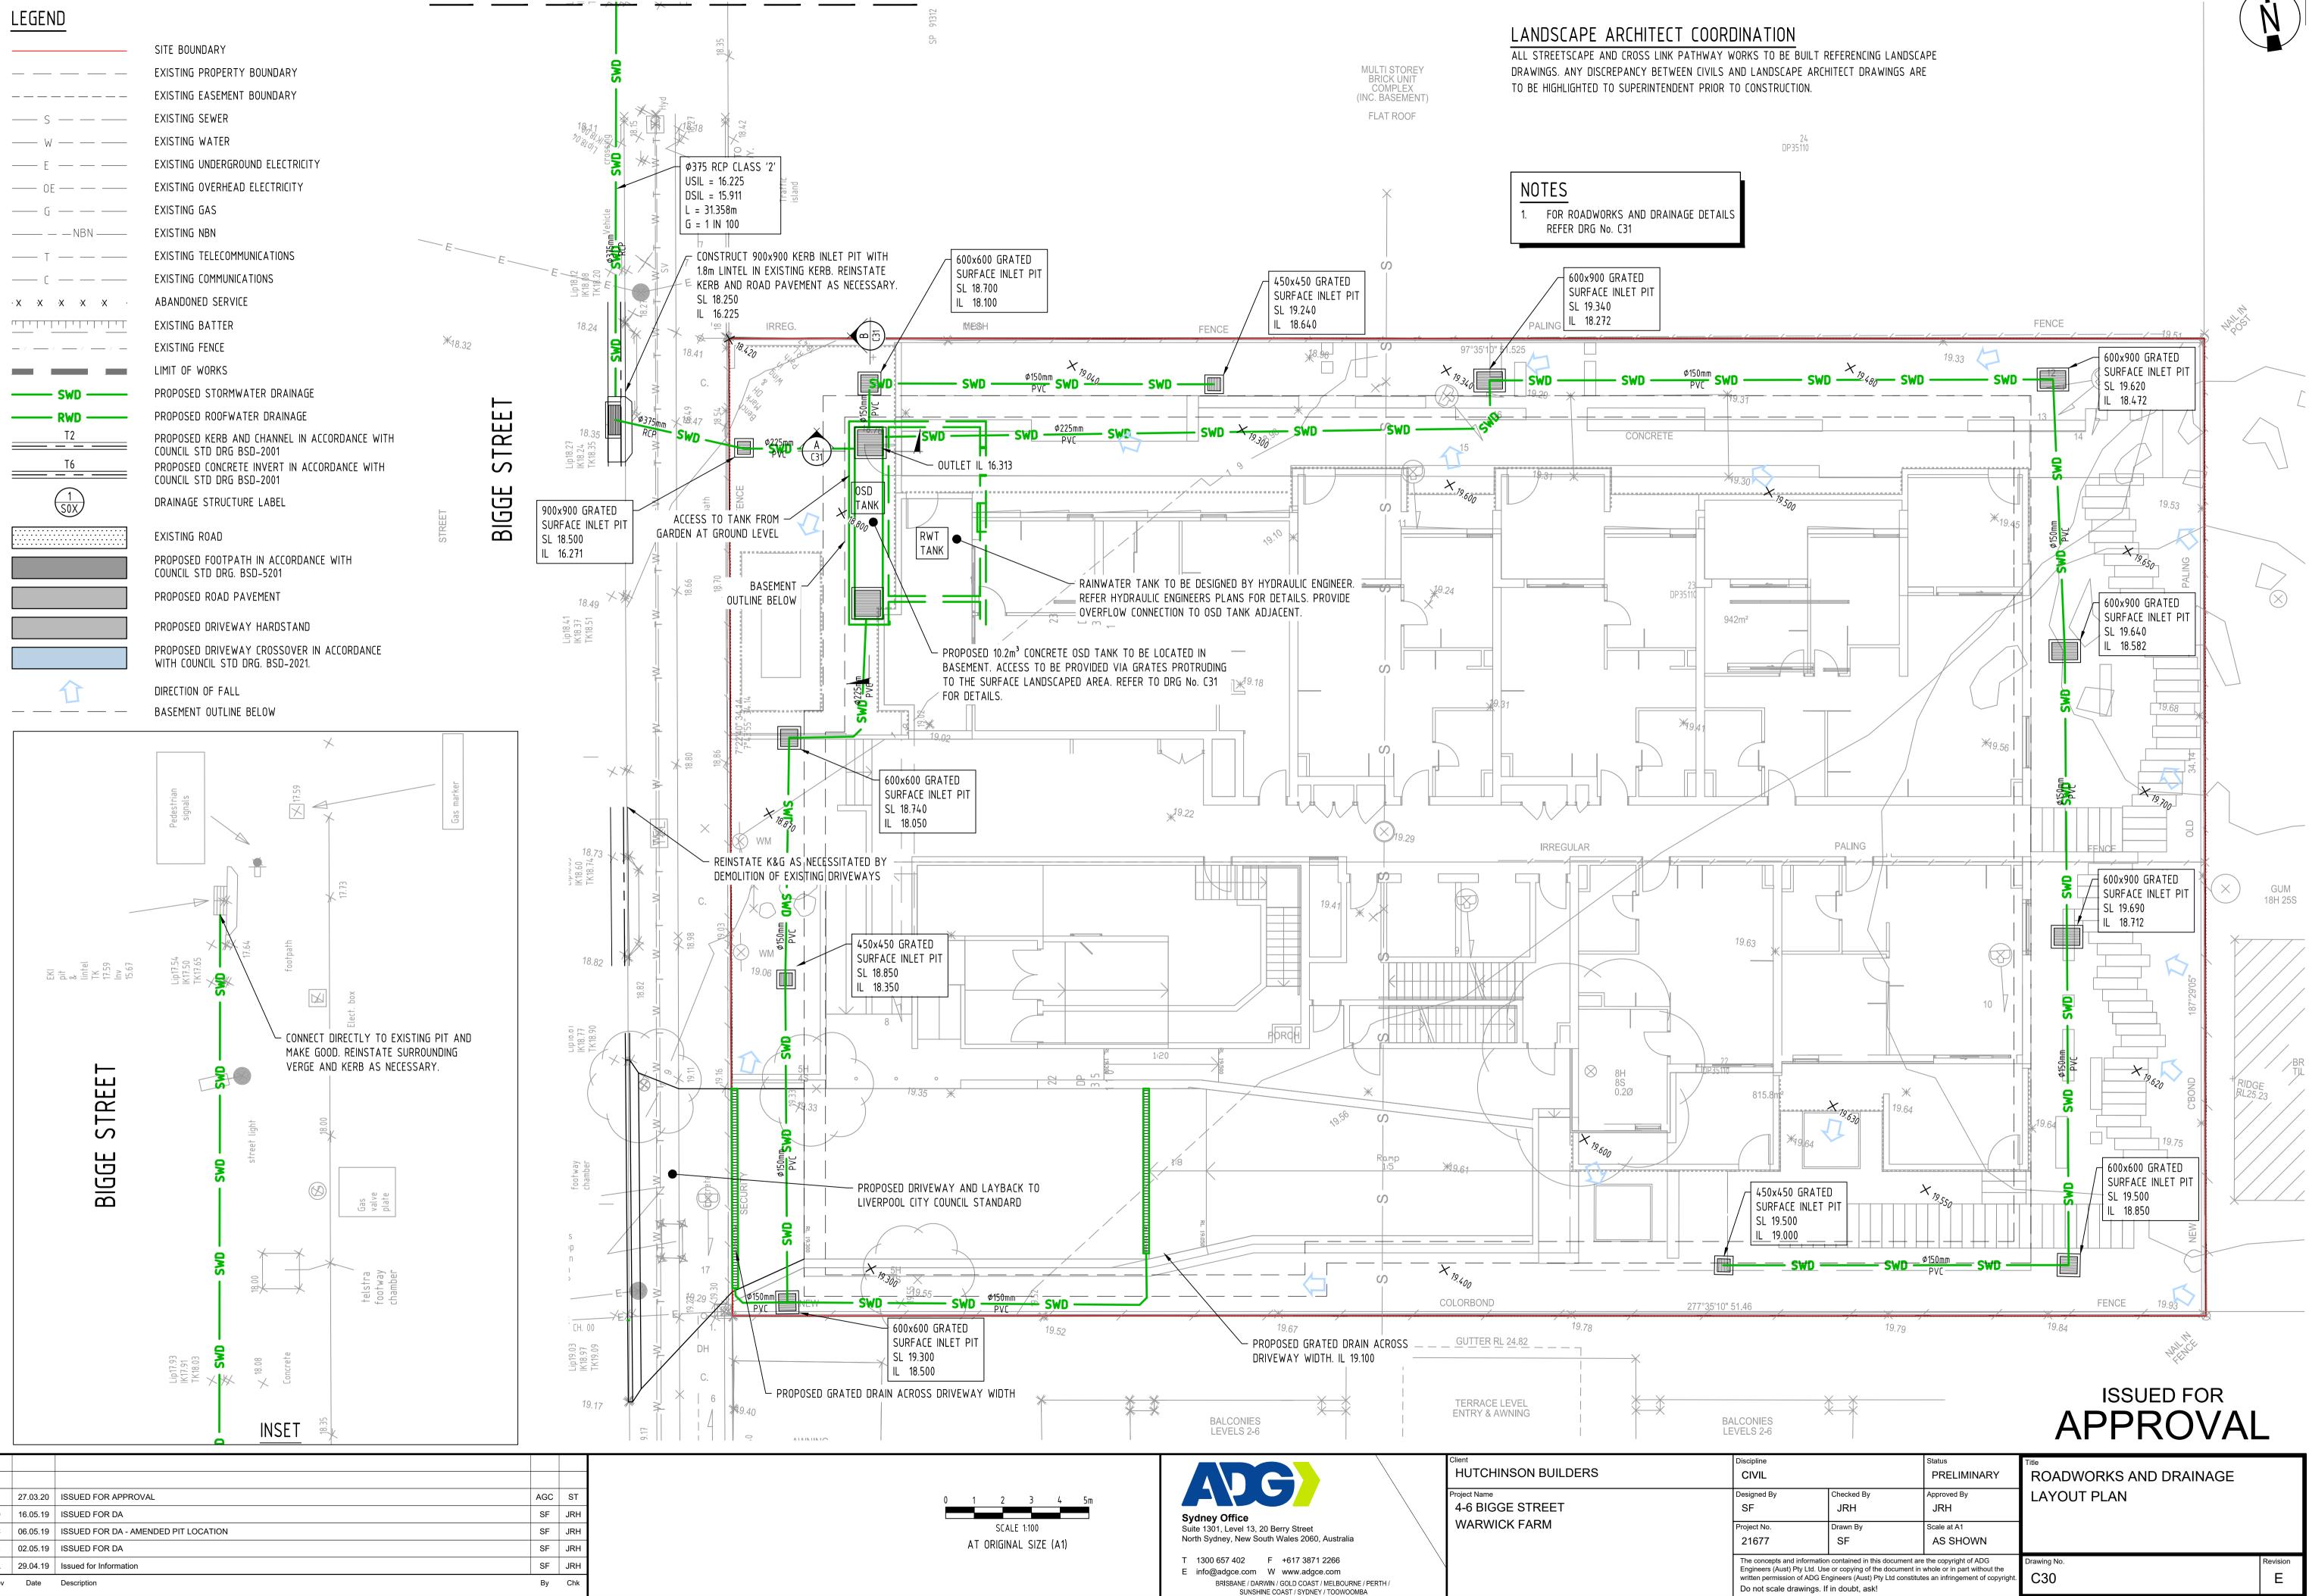

Е	27.03.20	ISSUED FOR APPROVAL	AGC	ST
D	16.05.19	ISSUED FOR DA	SF	JRH
С	06.05.19	ISSUED FOR DA - AMENDED PIT LOCATION	SF	JRH
В	02.05.19	ISSUED FOR DA	SF	JRH
А	29.04.19	Issued for Information	SF	JRH
Rev	Date	Description	Ву	Chk


PLOT DATE: 3/27/2020 2:02 PM FILENAME: \\192.168.8.4\JOBS\21000\21677\CVL\DWG\21677_C30_ROADWORK AND DRAINAGE LAYOUT PLAN.DWG

REFER INSET


												_
pline		Status	Title									
VIL		PRELIMINARY	ROADWORKS AND DRAINAGE									
gned By	Checked By	Approved By	LAYOUT PLAN									
-	JRH	JRH	_,			•						
ect No.	Drawn By	Scale at A1										
677	SF	AS SHOWN										
concepts and information contained in this document are the copyright of ADG ineers (Aust) Pty Ltd. Use or copying of the document in whole or in part without the ten permission of ADG Engineers (Aust) Pty Ltd constitutes an infringement of copyright. not scale drawings. If in doubt, ask!											Revision E	
		FULL SIZE ON ORIGINAL () 10	20	1 30	 40	ا 50	60	 70	80	 90	1 100mm

ROADWORKS AND DRAINAGE NOTES

- 1. REFER TO DWG C01 FOR GENERAL NOTES.
- 2. REFER HYDRAULIC DRAWINGS FOR BASEMENT, ROOF AND UPPER LEVEL TERRACES DRAINAGE.
- 3. ALL ROADWORKS AND DRAINAGE (EXTERNAL TO SITE BOUNDARIES AND/OR COUNCIL OWNED DRAINAGE PIPES INTERNAL TO THE SITE BOUNDARIES) CONSTRUCTION AND TESTING TO BE IN ACCORDANCE WITH LIVERPOOL CITY COUNCIL DEVELOPMENT GUIDELINES, DRAWINGS AND SPECIFICATIONS.
- 4. ALL DRAINAGE CONSTRUCTION (PRIVATELY OWNED DRAINAGE LINES INTERNAL TO THE SITE BOUNDARIES) CONSTRUCTED AND TESTED TO BE IN ACCORDANCE WITH RELEVANT AUSTRALIAN STANDARDS.
- 5. ALL STORMWATER DRAINAGE PIPES INTERNAL TO SITE SHALL BE: a) 225 DIA TO 375 DIA uPVC SN8 RUBBER RING JOINTED, BLACKMAX OR APPROVED EQUIVALENT.
- b) 450 DIA TO 600 DIA PP SN8 RUBBER RING JOINTED, BLACKMAX OR APPROVED EQUIVALENT
- 6. ALL STORMWATER DRAINAGE PIPES EXTERNAL TO SITE SHALL BE: a) 300 DIA AND GREATER CLASS 2 OR 3 R.C. RUBBER RING JOINTED
- 7. ALL STORMWATER PIPES ARE TO BE MANUFACTURED TO RELEVANT AUSTRALIAN STANDARDS INCLUDING BUT NOT LIMITED TO AS4058 AND AS1992.
- 8. STORMWATER DRAINAGE AND STRUCTURES HAVE BEEN DESIGNED FOR OPERATIONAL LOADS ONLY. CONTRACTOR TO CONSIDER CONSTRUCTION LOADINGS AND ENSURE NO EXCESSIVE LOADS ARE PLACED ON STORMWATER DRAINAGE OR STRUCTURES.
- 9. ALL PRECAST END STRUCTURES TO BE CONSTRUCTED WITH REINFORCED CONCRETE END WALL
- 10. CONTRACTOR TO CONFIRM LOCATION AND LEVEL OF EXISTING STORMWATER DRAINAGE WHERE CONNECTING ON TO EXISTING.
- 11. CONTRACTOR TO NOTIFY THE SUPERINTENDENT OF ANY UNSUITABLE FOUNDING MATERIAL WITHIN DRAINAGE TRENCH OR STORMWATER STRUCTURES AND AWAIT DIRECTION PRIOR TO LAYING OF PIPES.
- 12. TRENCH BACKFILL UNDER PAVEMENT TO BE COMPACTED TO 100% STANDARD DRY DENSITY (AS1289 5.1.1) IN LAYERS NOT EXCEEDING 150mm OF CBR 15 MATERIAL OR APPROVED EQUIVALENT. TRENCH BACKFILL IN ROADS TO BE MINIMUM CBR15 MATERIAL UP TO ROAD SUBGRADE LEVEL.
- 13. ALL STORMWATER GRATES/LIDS WITHIN TRAFFICABLE AREAS TO BE CLASS "D" IN ACCORDANCE WITH AS3996.
- 14. ALL GRATES AND LIDS SHALL SIT FLAT WITH ITS SURROUND AND NOT BE LOOSE OR MOVE UNDER WHEEL LOADS.
- 15. ALL STORMWATER STRUCTURES TO BE CONSTRUCTED IN ACCORDANCE WITH PROJECT SPECIFICATION, AND LOCAL AUTHORITY GUIDELINES AND SPECIFICATIONS. WHERE STRUCTURES EXCEED MAXIMUM DEPTH AS IDENTIFIED WITHIN STANDARD DRAWINGS THE CONTRACTOR WILL ENSURE AN ADEQUATE STRUCTURAL DESIGN IS UNDERTAKEN FOR THE SUBJECT STRUCTURE TO BE CONSTRUCTED TO.
- 16. CONTRACTOR TO ENSURE ALL MANHOLE STRUCTURES COMPLY WITH THE MAXIMUM DEPTH SPECIFIED IN THE PROJECT SPECIFICATION OR LOCAL AUTHORITY FROM FINISHED SURFACE LEVEL TO UNDERSIDE OF ROOF SLAB. ANY NON CONFORMANCE IS TO BE RECTIFIED AT THE CONTRACTORS EXPENSE.
- 17. CONTRACTOR TO INSTALL STEP IRONS WITHIN MANHOLES/FIELD INLETS WHERE REQUIRED BY LOCAL AUTHORITY.
- 18. ALL FOOTPATHS TO BE CONSTRUCTED IN ACCORDANCE WITH ARCHITECTURAL/LANDSCAPING DRAWINGS AND RELEVANT AUTHORITY STANDARD DRAWINGS AND SPECIFICATIONS. FOOTPATHS TO BE CONSTRUCTED WITH MAXIMUM 2% CROSSFALL. SHOULD CONSTRUCTED FOOTPATHS EXCEED 2.5% CROSSFALL, THE CONTRACTOR WILL BE REQUIRED TO RECTIFY BY REMOVING AND REPLACING AT THEIR COST.
- 19. WHERE A STORMWATER DRAINAGE TRENCH HAS BEEN CONSTRUCTED LONGITUDINALLY IN THE ROAD, THEN THE FINAL PAVEMENT SURFACE REPAIR WIDTH IS TO MATCH THE EXISTING LANE WIDTH AND TERMINATE 50mm CLEAR OF THE ROAD CENTERLINE OR LANE LINE LINEMARKING TO ALLOW FOR THE BITUMEN EMULSION JOINT SEAL. REINSTATEMENT OF SURFACE ADJACENT TO THE KERB OR ROAD PAVEMENT EDGE TO EXTEND FULLY TO THE KERB LINE OR EDGE OF PAVEMENT.
- 20. THE CONTRACTOR IS TO CONFIRM THE LOCATION OF SERVICE CONDUITS WITH THE SUPERINTENDENT PRIOR TO LAYING STORMWATER DRAINAGE. ALL TRENCH EXCAVATION AND CONSTRUCTION SHALL COMPLY WITH THE REQUIREMENTS OF THE QUEENSLAND WORKPLACE HEALTH AND SAFETY ACT 2011.
- 21. REMOVE ANY REDUNDANT DRAINAGE OUTLETS FROM THE KERB AND CHANNEL INCLUDING ANY ASSOCIATED PIPEWORK ACROSS THE FOOTWAY AND REINSTATE THE KERB AND CHANNEL AND THE FOOTWAY AREA IN ACCORDANCE WITH COUNCIL GUIDELINES.
- 22. CONTRACTOR TO UNDERTAKE ROADWORKS TESTING IN ACCORDANCE WITH COUNCIL GUIDELINES, DRAWINGS AND SPECIFICATIONS.
- 23. CONTRACTOR TO UNDERTAKE AND PROVIDE CCTV OF ALL STORMWATER LINES AT ON MAINTENANCE AND OFF MAINTENANCE. SHOULD THE CCTV IDENTIFY DAMAGE OR CRACKING WITHIN THE STORMWATER PIPES, THE CONTRACTOR WILL RECTIFY THE DAMAGE WITHIN THE PIPES BY MEANS DIRECTED BY THE SUPERINTENDENT WHICH MAY INCLUDE BUT NOT BE LIMITED TO PIPE RELINING OR PIPE REPLACEMENT.

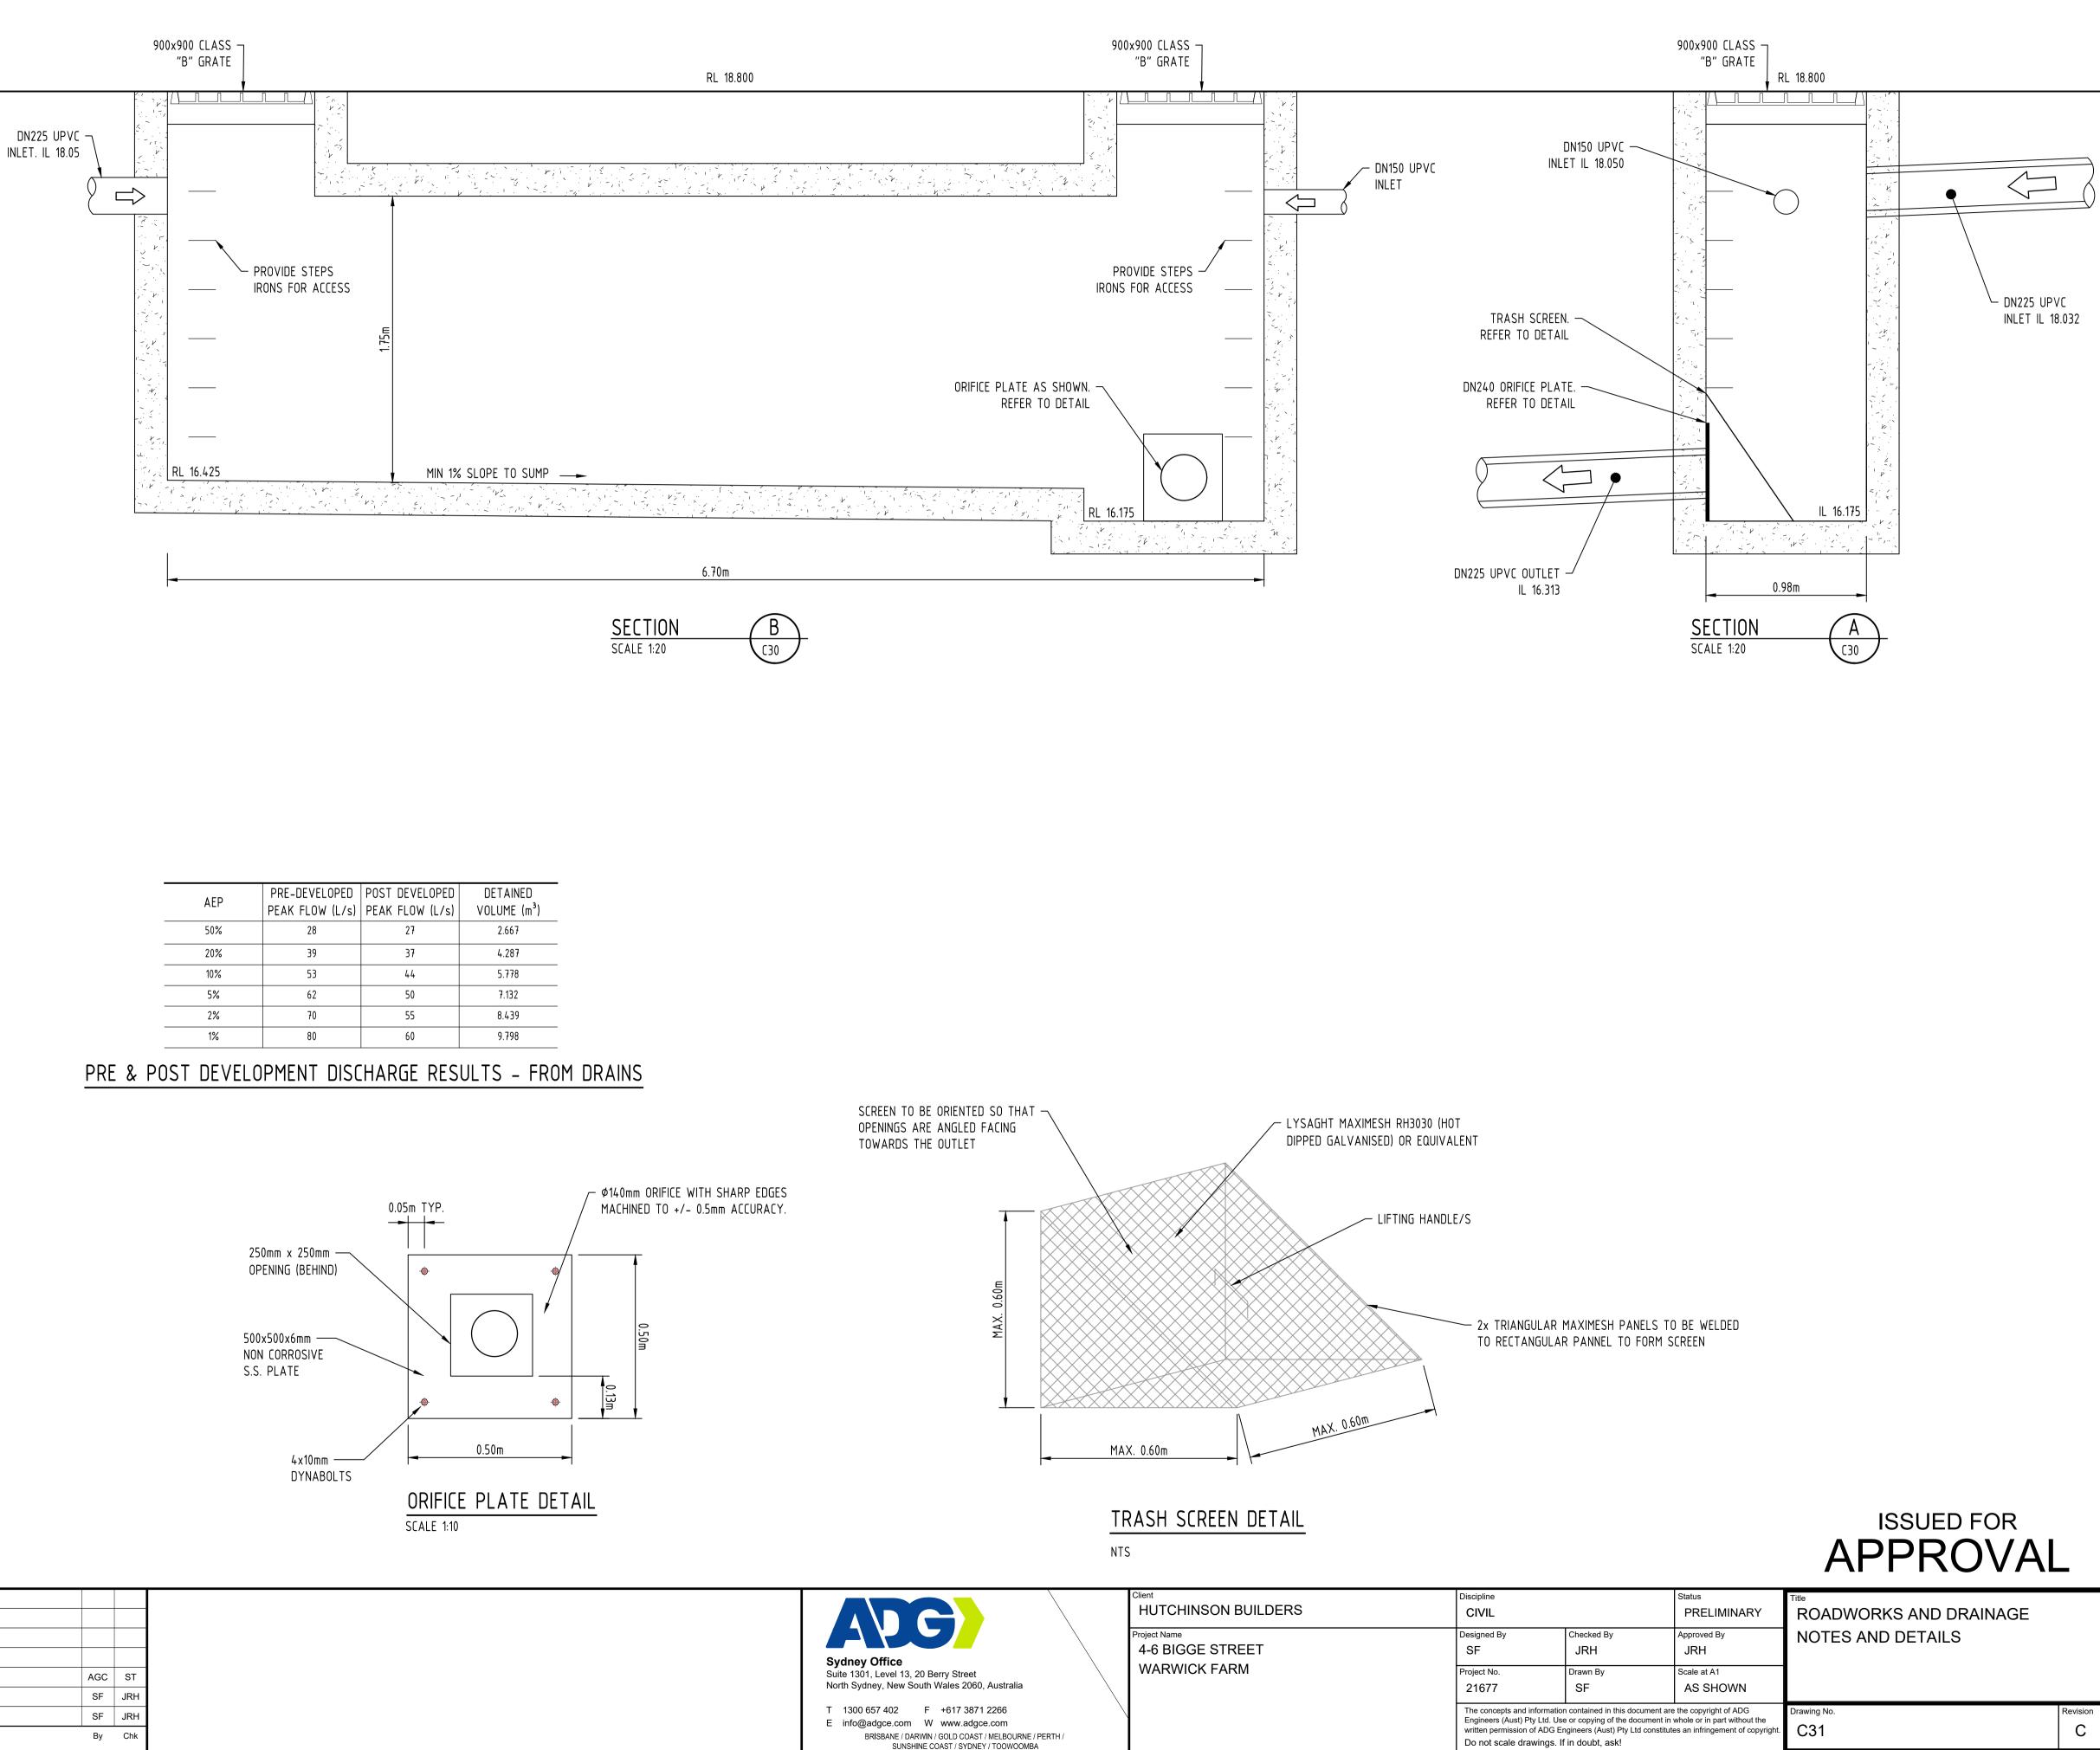

	PRE-DEVELOPED	POST DEVELOPED				
AEP	PEAK FLOW (L/s)	PEAK FLOW (L/s)				
50%	28	27				
20%	39	37				
10%	53	44				
5%	62	50				
2%	70	55				
1%	80	60				

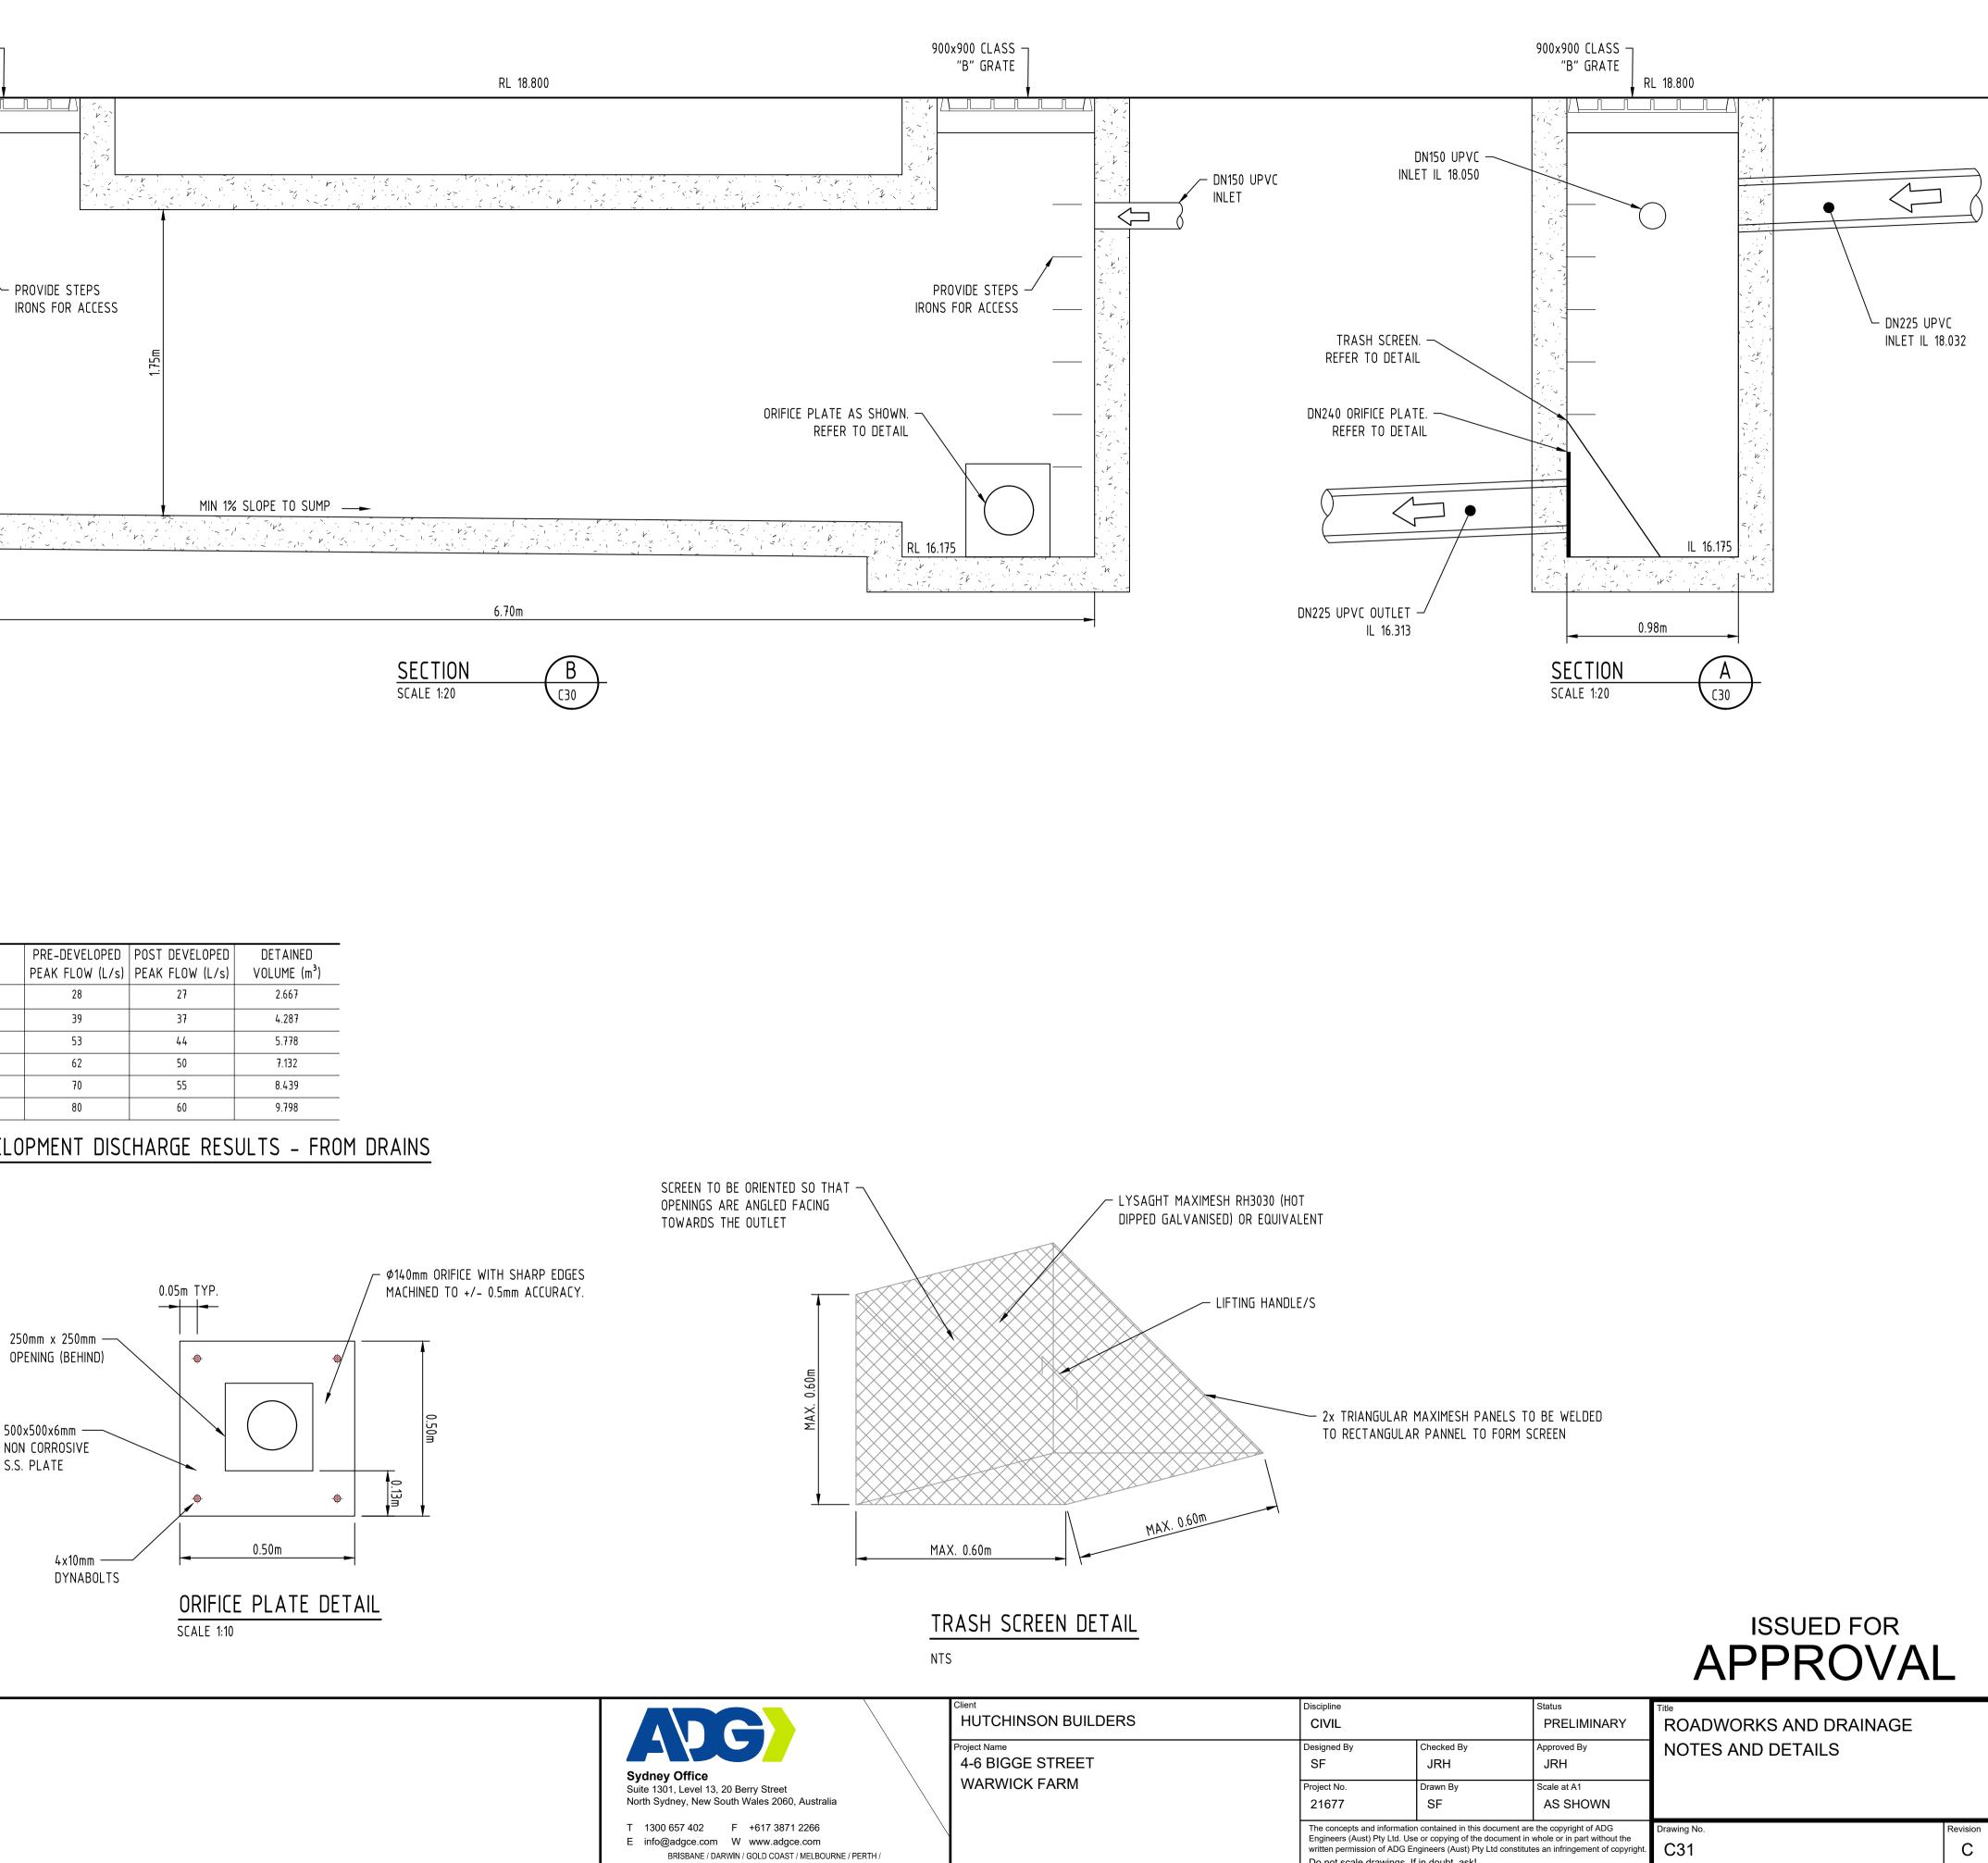

С	27.03.20	ISSUED FOR APPROVAL	AGC	ST
В	16.05.19	ISSUED FOR DA	SF	JRH
А	02.05.19	ISSUED FOR DA	SF	JRH
Rev	Date	Description	Ву	Chk

/IL		PRELIMINARY	ROA	_				RAIN	AGE			
ned By Checked By JRH		Approved By JRH	NOTES AND DETAILS									
t No. 677	Drawn By SF	Scale at A1 AS SHOWN										
neers (Aust) Pty Ltd. Use			Drawing No								Revision C	
		FULL SIZE ON ORIGINAL (1 I D 10	20	1 30	1 40	50	60	1 70	80	90	1 100 mm